


DIST.	COUNTY	ROUTE	POST MILES TOTAL PROJECT	SHEET No.	TOTAL SHEETS
REGISTERED CIVIL ENGINEER			DATE		
PLANS APPROVAL DATE					
<small>The State of California or its officers or agents shall not be responsible for the accuracy or completeness of scanned copies of this plan sheet.</small>					
<small>The Registered Civil Engineer for the project is responsible for the selection and proper application of the component design and any modifications shown.</small>					

**NOTES:**

1. Unless noted all dowels are drilled and bonded with minimum embedment length of 8".
2. Top of multilayer polymer concrete overlay, polyester concrete, and SCC placed at deck profile.
3. Seismic joint position shown at 70 °F.

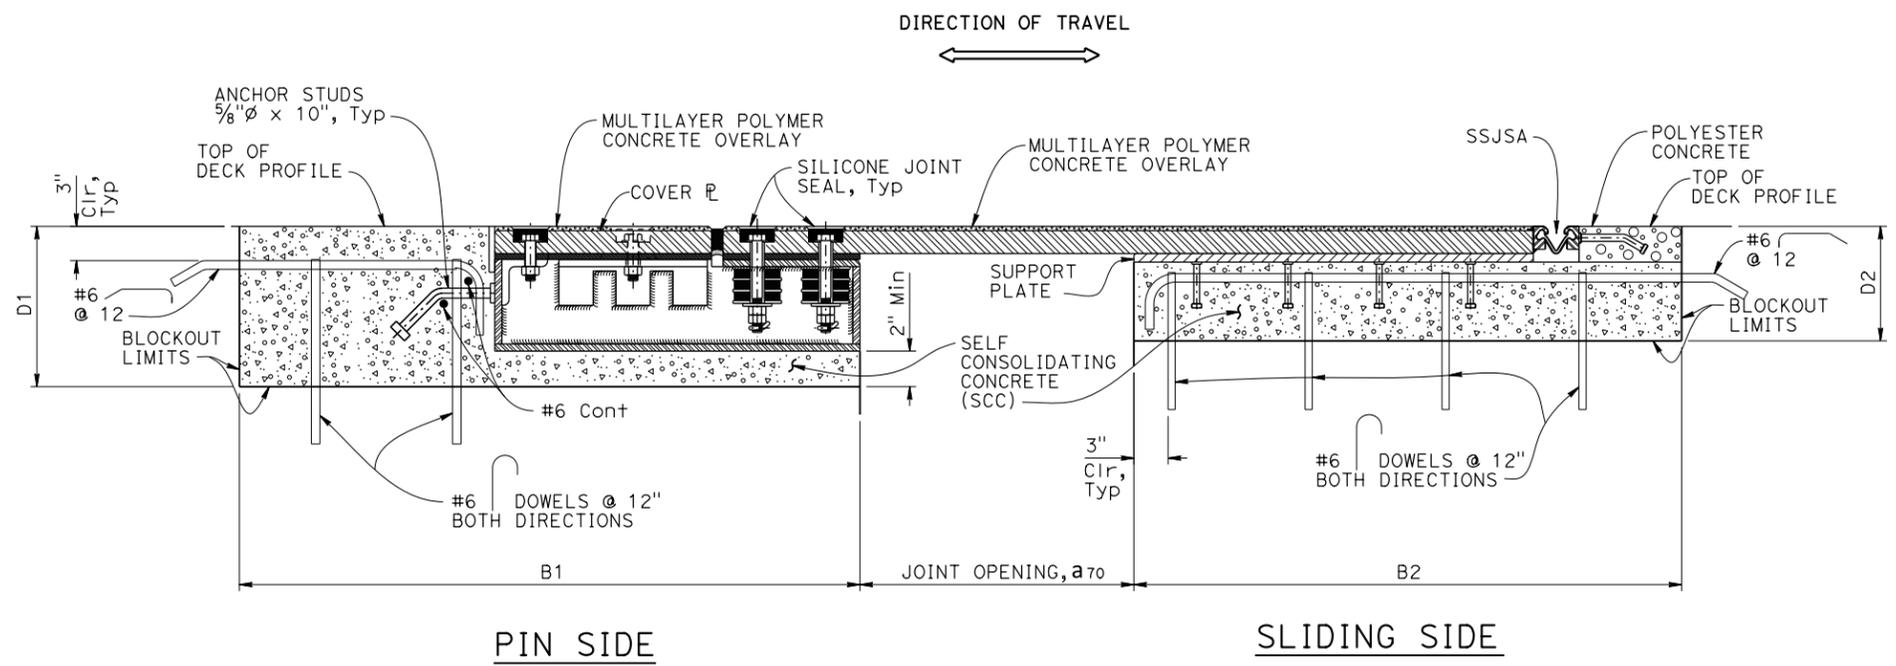

**ELEVATION**  
1 1/2" = 1'-0"

BRIDGE STANDARD DETAILS			<b>STATE OF CALIFORNIA</b> DEPARTMENT OF TRANSPORTATION			BRIDGE NO. POST MILE			<b>SEISMIC JOINT (TYPE I, FULL CHANNEL)</b> <b>REINFORCEMENT DETAILS</b>			
FILE NO. <b>xs8-070-7</b>	APPROVAL DATE July 2016	<small>The components of the Bridge Standard Details have been prepared under the responsible charge of the Technical Owner, a registered civil engineer in the State of California.</small>										DIVISION OF <b>ENGINEERING SERVICES</b>
<small>Refer to: <a href="http://www.dot.ca.gov/hq/esc/techpubs/manual/bridgemanuals/bridge-standard-detail-sheets/index.html">http://www.dot.ca.gov/hq/esc/techpubs/manual/bridgemanuals/bridge-standard-detail-sheets/index.html</a></small>			FILE => xs8-070-7.dgn USERNAME => s136236	TIME PLOTTED => 15:14	DATE PLOTTED => 14-JUL-2016	ORIGINAL SCALE IN INCHES FOR REDUCED PLANS 0 1 2 3	UNIT: PROJECT NUMBER & PHASE:	CONTRACT NO.:	DISREGARD PRINTS BEARING EARLIER REVISION DATES	REVISION DATES 11-25-15 7-11-16	SHEET 7	OF 9